



GENERAL NOTES


- ALL CONSTRUCTION AND MATERIALS TO COMPLY WITH THE REQUIREMENTS OF N-BRC'S HOME BUILDERS MANUALS AND SANS 1040, UNLESS OTHERWISE AGREED THROUGH RATIONAL DESIGN.
- PROVISION TO BE MADE OF STORM WATER RUNOFFS
- WHERE ELECTRICAL INSTALLATION IS REQUIRED SPECIFICATION WILL BE PROVIDED
- THIS DRAWING IS NOT TO BE SCALED
- ALL DIMENSION AND LEVELS TO BE CHECKED AND VERIFIED BEFORE ANY WORK COMMENCE ON SITE
- DISCREPANCIES TO BE REPORTED TO PROJECT MANAGER

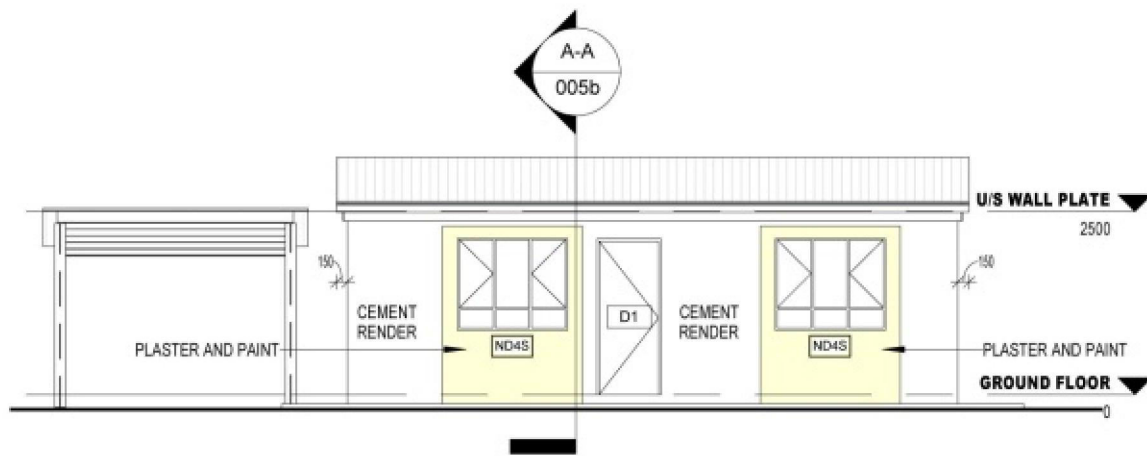

FRONT ELEVATION (b)
1 : 100

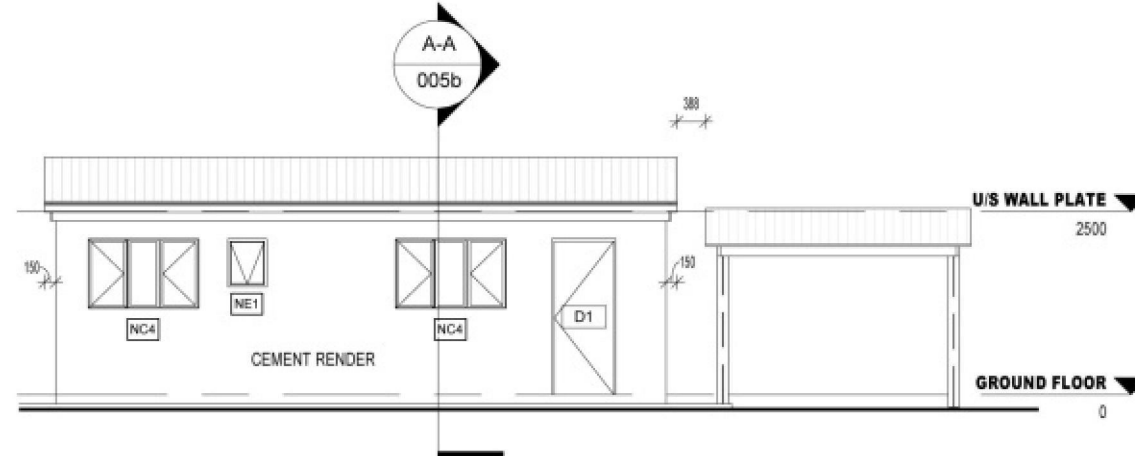


BACK ELEVATION (b)
1 : 100

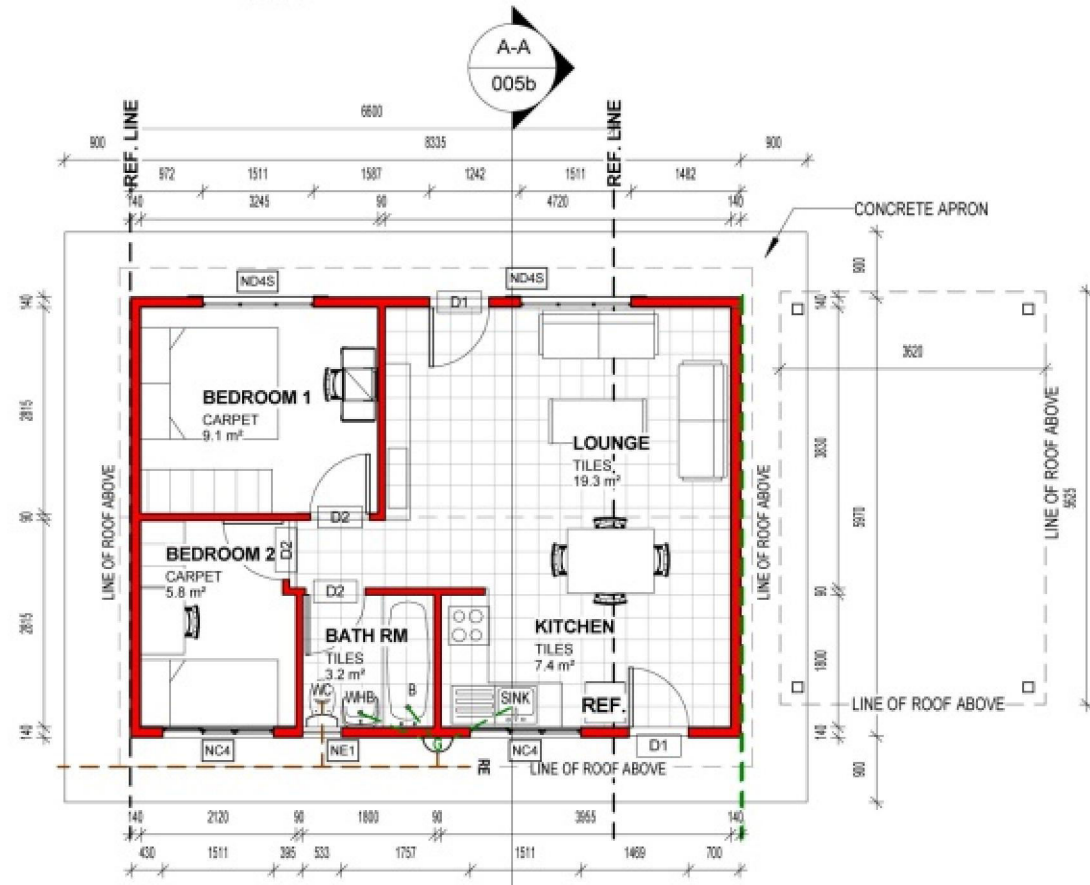


PLAN (b)
1 : 100

TOTAL AREA: 51 m²

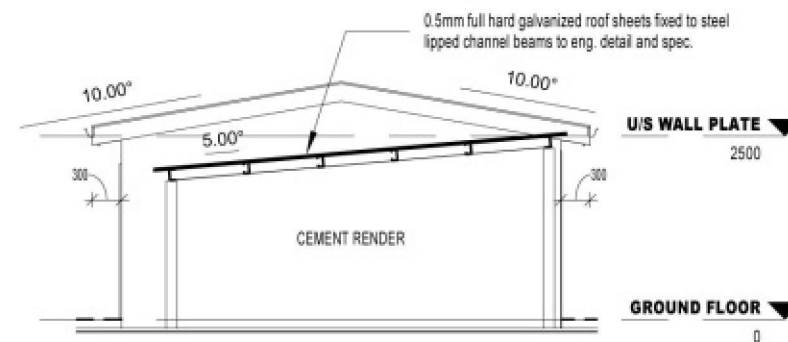

SIDE ELEVATION (b)
1 : 100

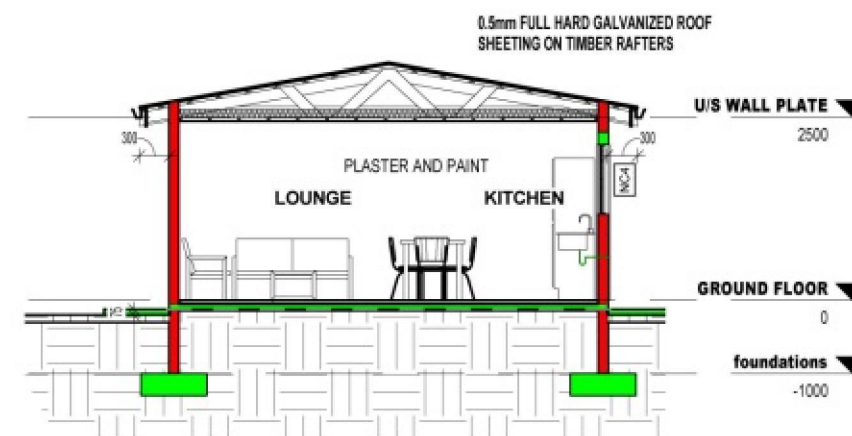

SECTION A-A (b)
1 : 100

WINDOW SCHEDULE_b	
REF. NO.	DESCRIPTION
PER UNIT	
NC4	2 (C-type residential open out): 1511mm(w) x 948mm(h)
ND4S	2 (D-type residential open out): 1511mm(w) x 1245mm(h)
NE1	1 (E-type top hung residential open out): 533mm(w) x 654mm(h)

DOOR SCHEDULE_b	
REF. NO.	DESCRIPTION
PER UNIT	
D1	2 EXTERNAL DOOR: 813mm(w) x 2032mm(h)
D2	3 INTERNAL DOOR: 813mm(w) x 2032mm(h)

NOTE:
ALL DOOR AND WINDOW LINTOL HEIGHTS AT 2100mm FROM T.O.C OF GROUND FLOOR LEVEL OR AS SPECIFIED OTHERWISE

CLIENT: DEPARTMENT OF HUMAN SETTLEMENTS
PROJECT: SUBSIDY HOUSING TYPOLOGY STUDY



DWG NAME: TYPE 5b HOUSE FOR MILITARY VETERANS 50sqm
DWG DESCRIPTION: PLAN, ELEVATIONS AND SECTION

DATE: 10/12/2012	SCALE: 1 : 100	SHEET SIZE: A3
DWG NO: 005b	REV. NO:	